



				AMENDMENT REGISTER													
AMD.	ISSUE	REVISION	DRAWING	DESCRIPTION SUMMARY					SHEE	ETS /	ADDED	OR C	CHANGE	ED			
NO.	DATE	DETAILS	PHASE		A01	A02	A03	A04	A05 A	406	A07 A	08 A0	9	S01 S	302 S0	3 S04	E01
1	05/02/25	CONCEPT - A	CONCEPT	CONCEPT DESIGN A - PRE DA		Х	Х	Х	Х	Х							
2	13/02/25	CONCEPT - B	CONCEPT	CONCEPT DESIGN B - PRE DA	X	_	Х			_							
3	13/02/25	DA - SET	DA SUBMISSON	FINAL DESIGN FOR DA SUBMISSON - SECTIONS ADDED	X	X	X	Х	Х	Х	Х						
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	DRAWING LIST
SHEET NO.	SHEET NAME
A100	Cover Sheet
A101	Site Plan
A102	Proposed Pool Area
A104	Elevations
A105	Elevations
A106	Sections
A107	Perspectives

As indicated



Kylie Farr

Governor - Pool & Cabana

Block: 17

Section: DP1144964

Issued

Rev


Description


17/02/2025 Cover Sheet Status DA SET A100 J.M Drawn by


Sheet size

12 Governor Drive

Suburb: MURRUMBATEMAN

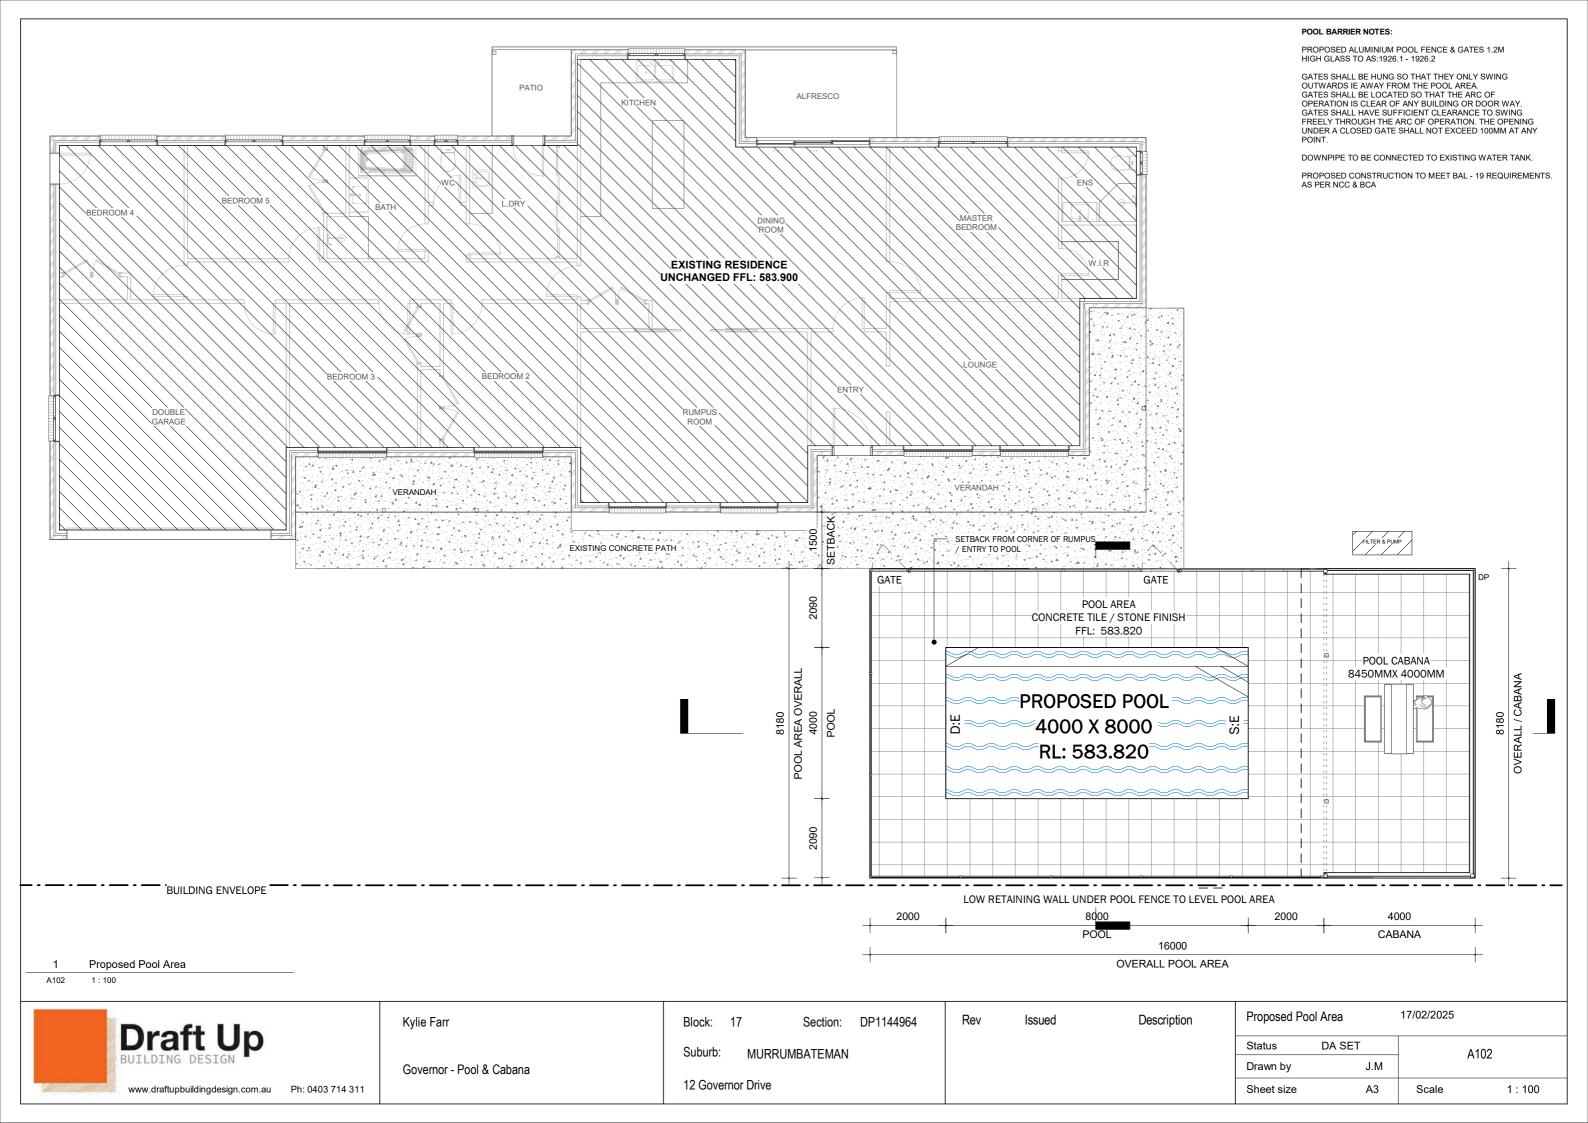

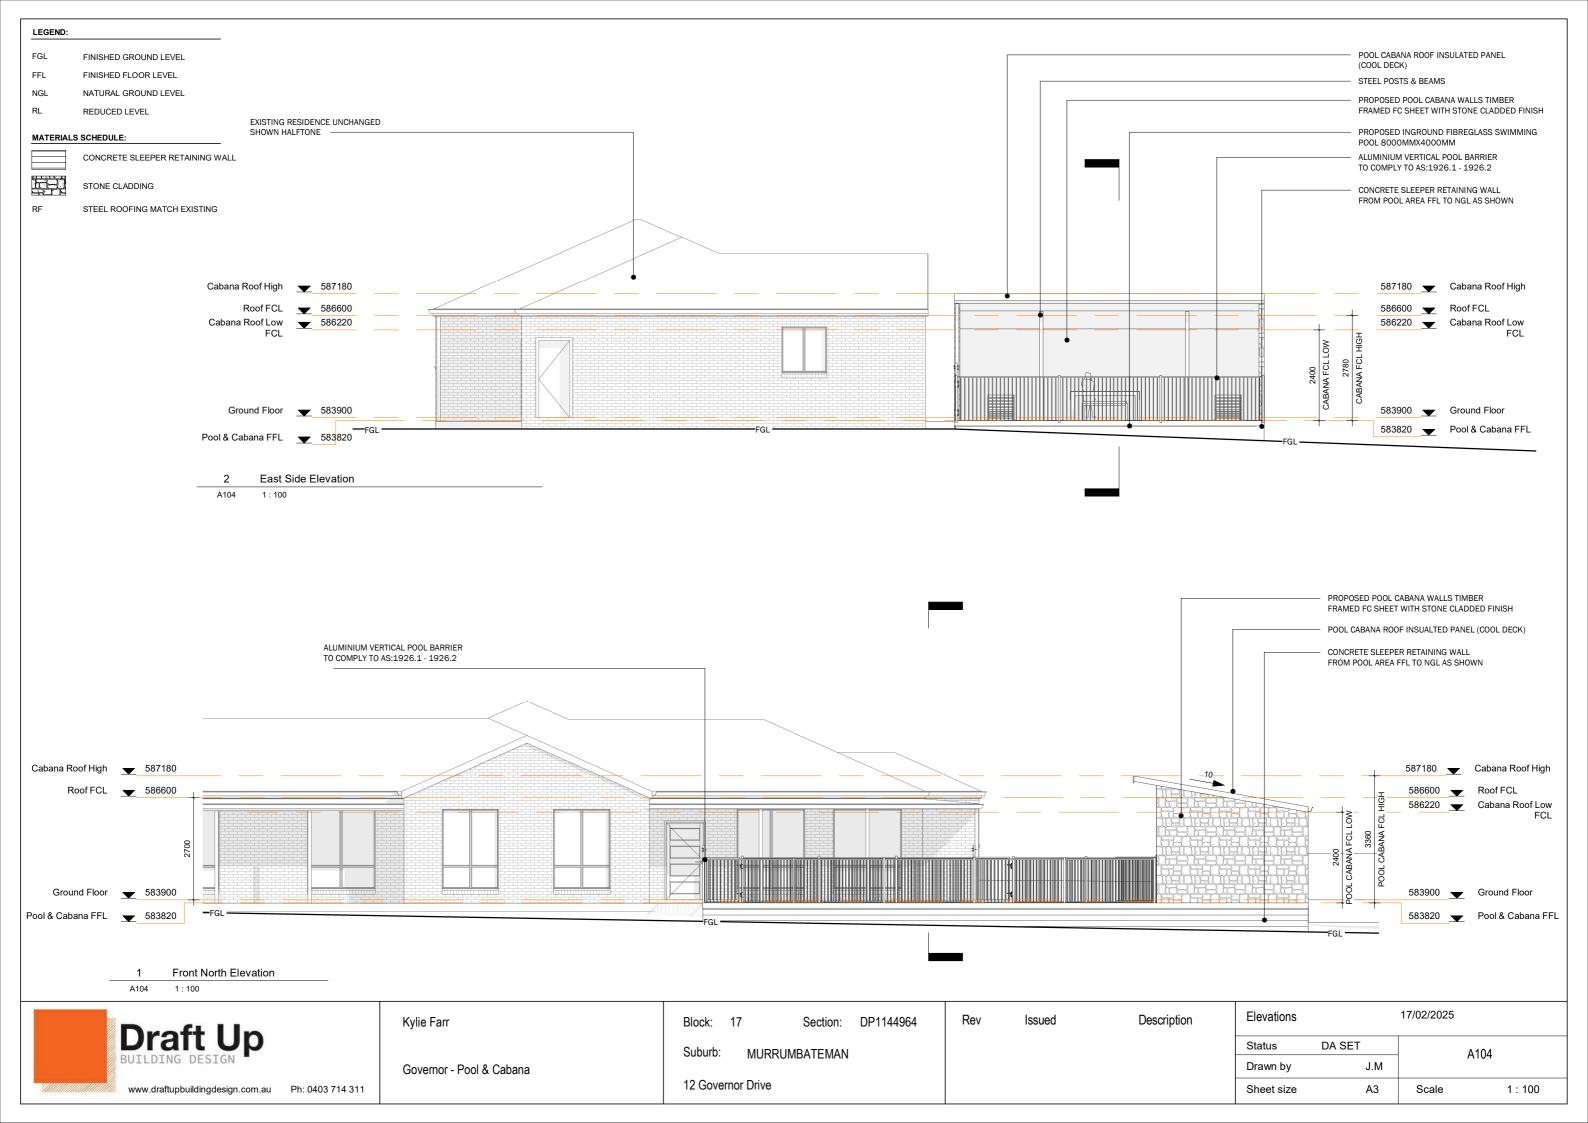

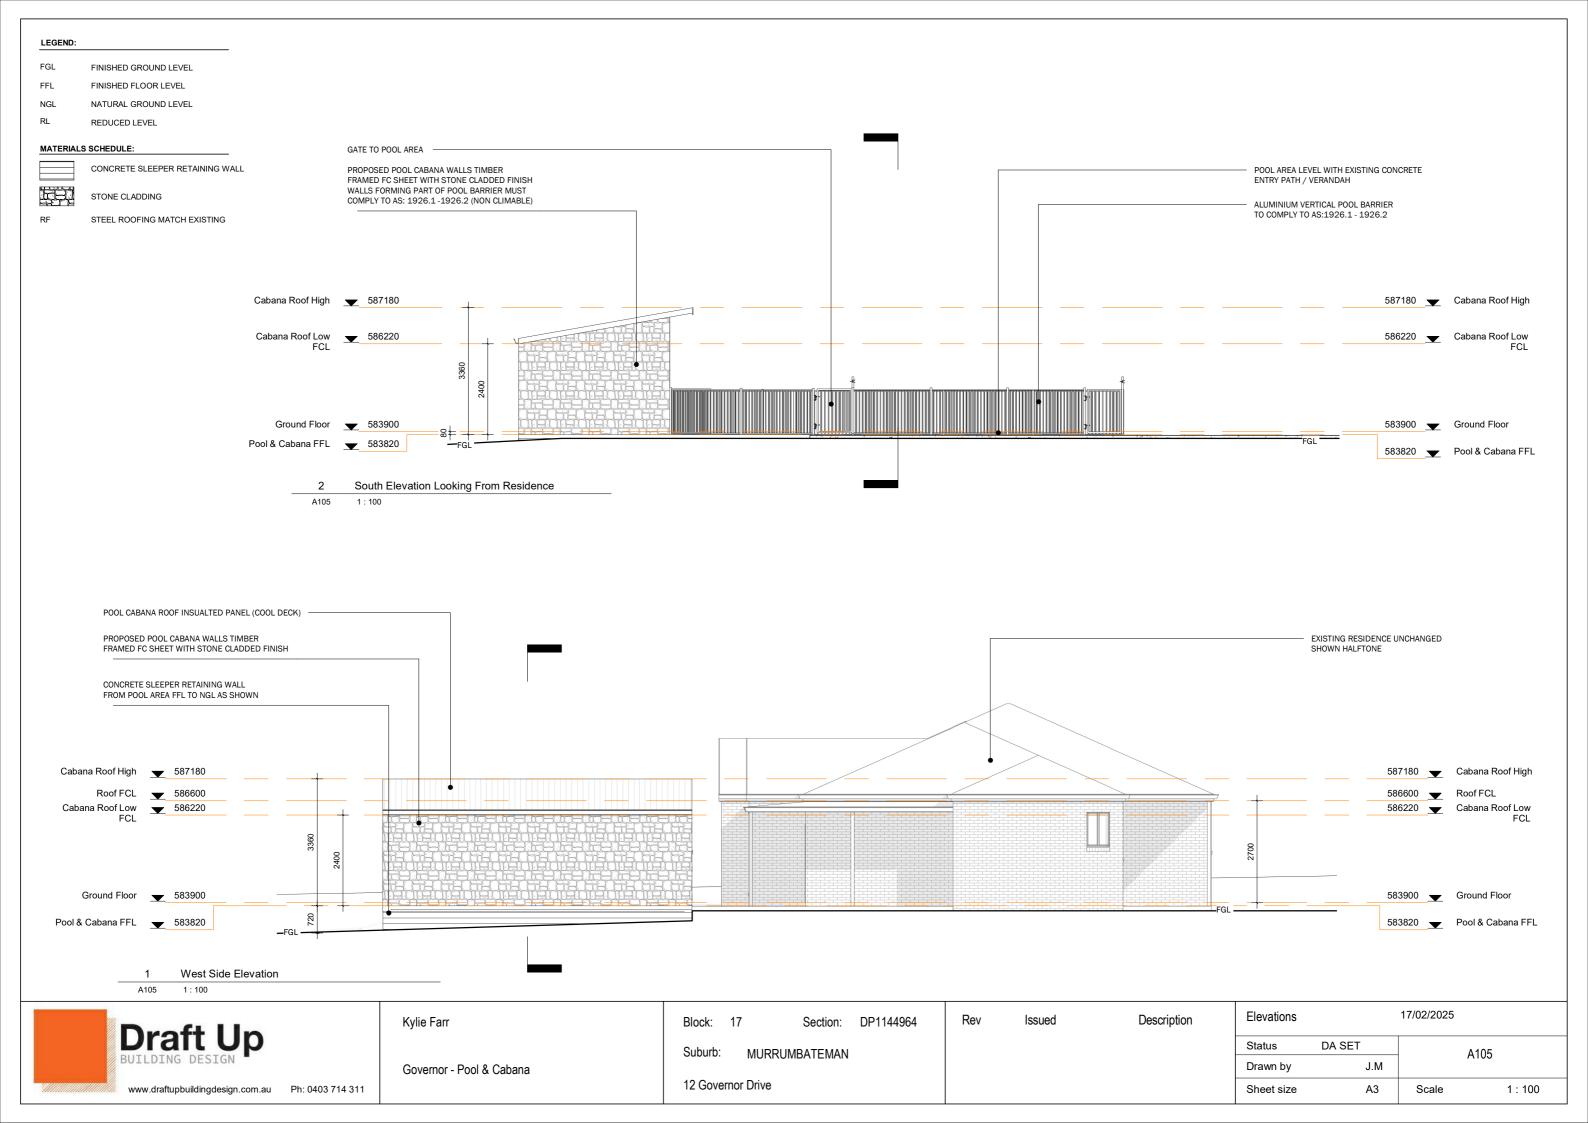

POOL NOTES:

- 1. POOL DESIGN AND INSTALLATION TO BE IN ACCORDANCE WITH
- AS/NZS 1838 & AS/NZS 1839. 2. CONCRETE TO BE IN ACCORDANCE WITH AS 3600 AND TABLE 1 OF AS
- -TO BE KEPT MOIST AND CURED FOR A MINIMUM OF 7 DAYS -N25/20 /80
- 3.REINFORCING STEEL YIELD STRENGTH FOR 'N' BARS fsy = 500 MPa -MINIMUM LAP AT SPLICES AND CORNERS = 400 mm -IF 400mm LAP CANNOT BE ACHIEVED THEN ADD N10 'L' BAR WITH 600mm LEGS TO EACH MESH BAR.
- CONCRETE COVER: WHEN CAST ON OR AGAINST GROUND = 60 mm
- CONCRETE COVER: WHEN CAST ON OR AGAINST GROUND = 60 HIM ELSEWHERE = 50 mm 4. THE FIBREGLASS SHELL SHALL HAVE A MINIMUM THICKNESS OF 5mm WITH 3 AYERS OF 0.025 LBS/FT2 ROVINGS. THE FLOOR SHALL HAVE 3 LAYERS F HOP STRAND FIBREGLASS. 5.THE RIBS SHALL HAVE 1 LAYER OF 600 gr/m2 ROVINGS OVER RIBS
- FORMS LAMINATED TO POOL WALLS. RESIN TO GLASS RATIO 2.25: 1 BY WEIGHT. RIP RAILS & COPING TO BE 10mm MIN. THICKNESS.
- 6.FILTER TO BE CONNECTED TO SKIMMER BOX & WATER RETURN PORTS 11H 40mm IA. PVC PRESSURE PIPE & FITTINGS & SHALL COMPLY WITH AS 1926.3 WATER RETICULATION SYSTEMS. FIT UP TO HYDROSTATIC VALVE. RETURN PIPES SHALL BE 50MM DIA

BARRIER NOTES:

PROPOSED ALUMINIUM POOL FENCE & GATES 1.2M HIGH GLASS TO AS:1926.1 - 1926.2 PROPOSED STEEL BOUNDARY BARRIER TO COMPLY TO AS:1926.1 - 1926.2 MIN 1.8M HIGH GATES SHALL BE HUNG SO THAT THEY ONLY SWING OUTWARDS IE AWAY FROM THE POOL AREA. GATES SHALL BE LOCATED SO THAT THE ARC OF OPERATION IS CLEAR OF ANY BUILDING OR DOOR WAY GATES SHALL HAVE SUFFICIENT CLEARANCE TO SWING FREELY THROUGH THE ARC OF OPERATION. THE OPENING UNDER A CLOSED GATE SHALL NOT EXCEED 100MM AT ANY

BUILDING NOTES:

ALL CONCRETE FOOTINGS AND SLABS TO BE IN ACCORDANCE WITH S.A.A CODE 2870.1 & ENGINEER'S SPECIFICATION.

PROVIDE CONTINUOUS DAMPROOF MEMBRANE UNDER SLAB.

PROVIDE DAMPROOF COURSE AT PROVIDE DAMPROOF COURSE AT BEARER SEATING LEVELS, PROVIDE STEPPED CAVITY FLASHING WITH WEEP HOLE AT 1200MM CENTERS TO THE EXTERNAL BRICK SKIN AT GROUND FLOOR LEVEL, UNDER WINDOWS AND RECEIVED AT A PROVIDENCE. AND BRICKWORK ABOVE WINDOWS.

STAIRS, BALUSTRADES AND HANDRAILS
THE HEIGHT OF THE BALUSTRADE ON A FINISHED
FLOOR LEVEL, BALCONY, LANDING OR PATH MUST
BE ABOVE1000MM. OPENINGS IN THE BALUSTRADES MUST BE CONSTRUCTED SO THAT ANY OPENING DOES NOT PERMIT A 125MM SPHERE TO PASS THROUGH IT. THIS SPACE IS TESTED ABOVE THE NOSING LINE ONLY. A HANDRAIL SHOULD BE PROVIDED ALONG AT LEAST ONE SIDE OF THE STAIRS. THE HANDRAILS SHOULD BE CONTINUOUS. ALL STAIRS, BALUSTRADES AND HANDRAILS SHALL COMPLY WITH AS

TIMBER FRAMING:

TIMBER FRAMING AND SUB FLOOR VENTILATION MUST COMPLY WITH BCA VOL

2-2022, PART 6.1 SCOPE AND APPLICATION OF SECTION 6 TIMBER FRAMING TO BE INSTALLED ACCORDANCE WITH AS1684-2010 (OR


ALTERNATIVELY STEEL FRAMING IN ACCORDANCE WITH AS4100-1998 OR AS/NZS 4600-2018)


TERMITE PROTECTION TO BE INSTALLED ACCORDANCE WITH AS3660 OR BCA VOLUME 2, PART 3.1.4

BUSHFIRE

PROPOSED DEVELOPMENT IS ON BUSHFIRE PRONE LAND. LAND SPECIFIED AS
BAL - 19 IN BUSHFIRE ASSESMENT REPORT.
DEVELOPMENT TO BAL - 19 STANDARDS WITH AS3959 AND

ANY REQUIRMENTS
SETOUT BY YVC DURING THE DEVELOPMENT APPROVAL PROCSESS.

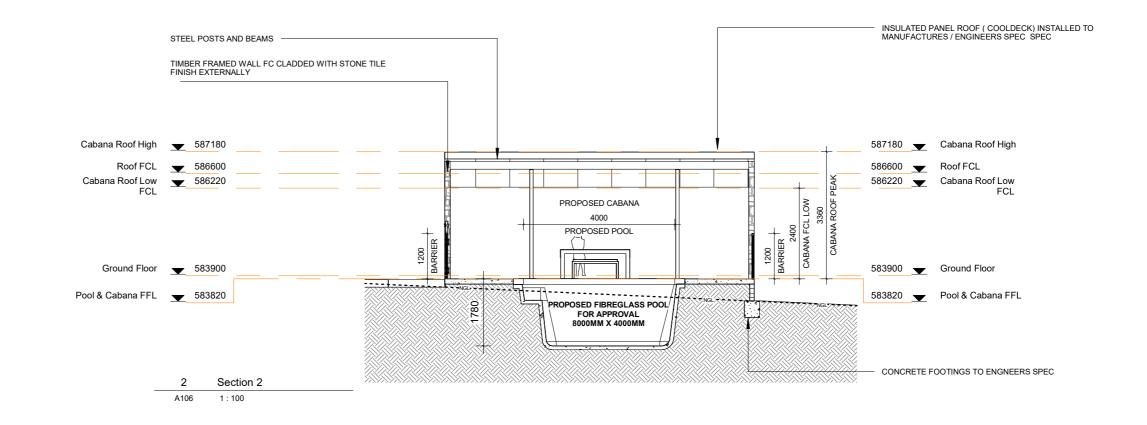

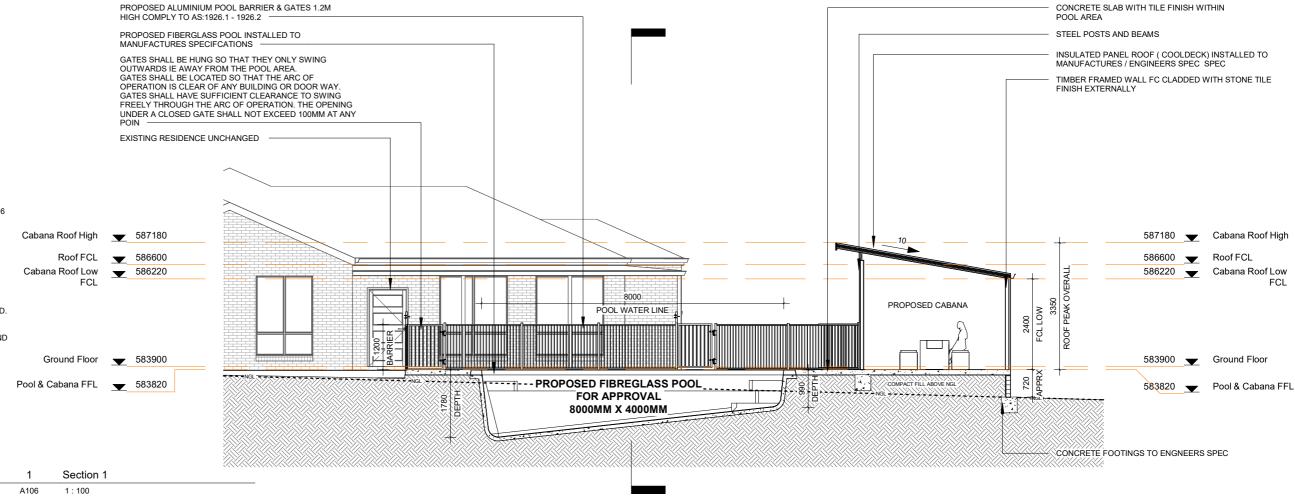

Rev



www.draftupbuildingdesign.com.au Ph: 0403 714 311

Kylie Farr Governor - Pool & Cabana

DP1144964 Block: 17 Section: Suburb: MURRUMBATEMAN

12 Governor Drive

Sections Issued Description DA SET Status J.M Drawn by

17/02/2025 A106 Sheet size Scale 1:100







Kylie Farr

Governor - Pool & Cabana

Block: 17 Section: DP1144964

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Issued

Suburb: MURRUMBATEMAN

12 Governor Drive

Description

 Perspectives
 17/02/2025

 Status
 DA SET

 Drawn by
 J.M

 Sheet size
 A3

 Scale
 1:1